




A. ESB SUBSTATION

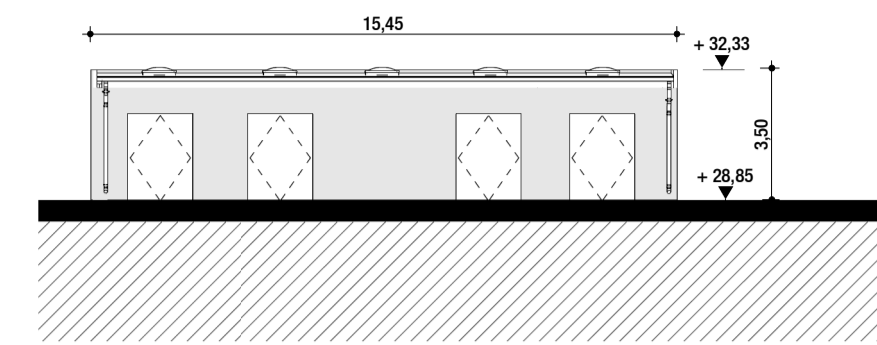


01 ESB Substation Front Elevation
Scale 1:200

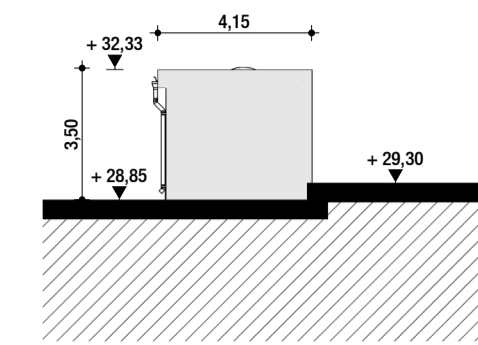


02 ESB Substation Left Side Elevation
Scale 1:200

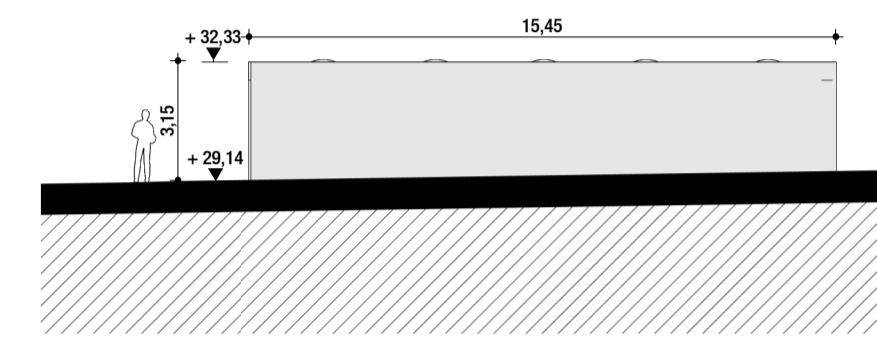


03 ESB Substation Rear Elevation 01
Scale 1:200

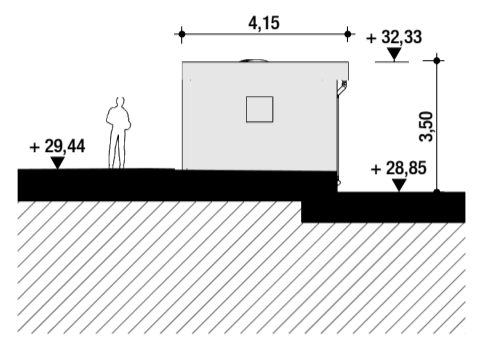


04 ESB Substation Right Side Elevation 01
Scale 1:200

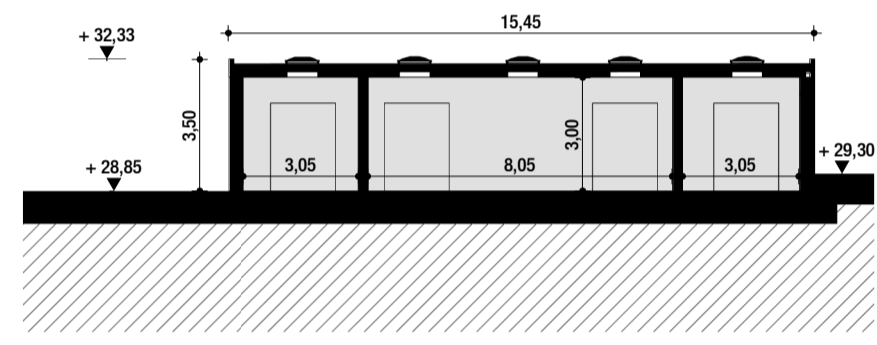


05 ESB Substation Rear Elevation 02
Scale 1:200

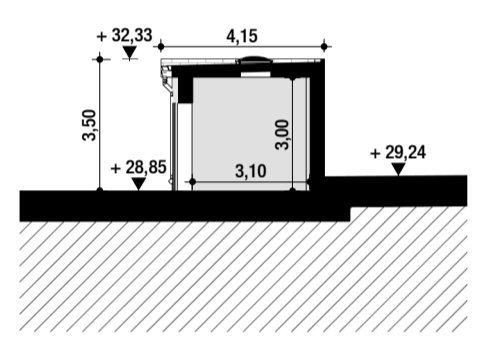

06 ESB Substation Left Side Elevation 02
Scale 1:200

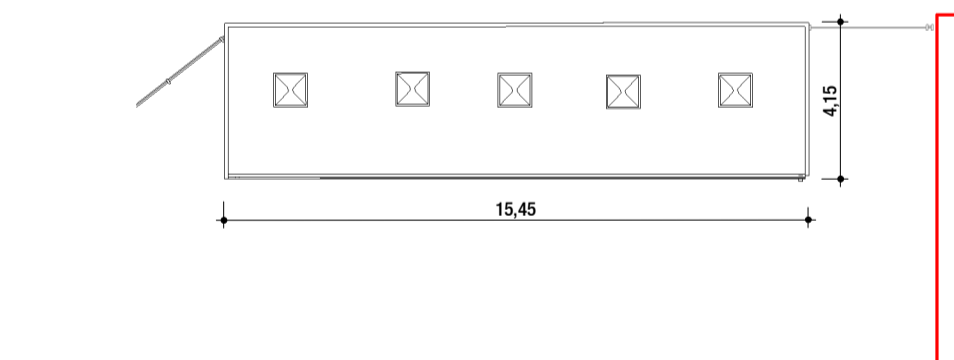


07 ESB Roof Plan
Scale 1:200

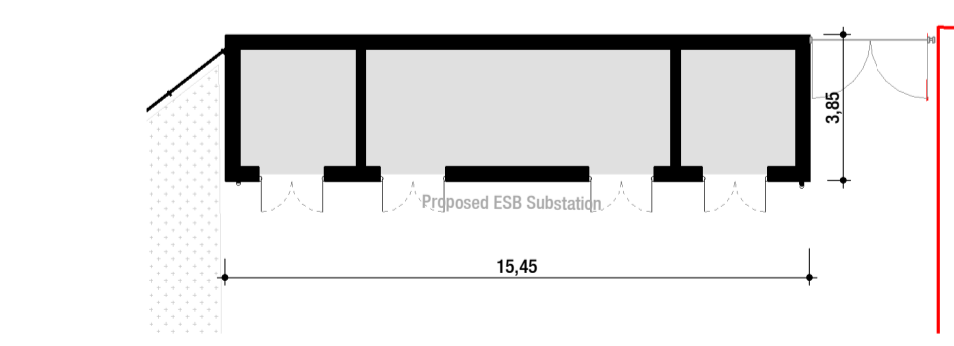


08 ESB Ground Floor
Scale 1:200


B. UTILITIES BUILDING

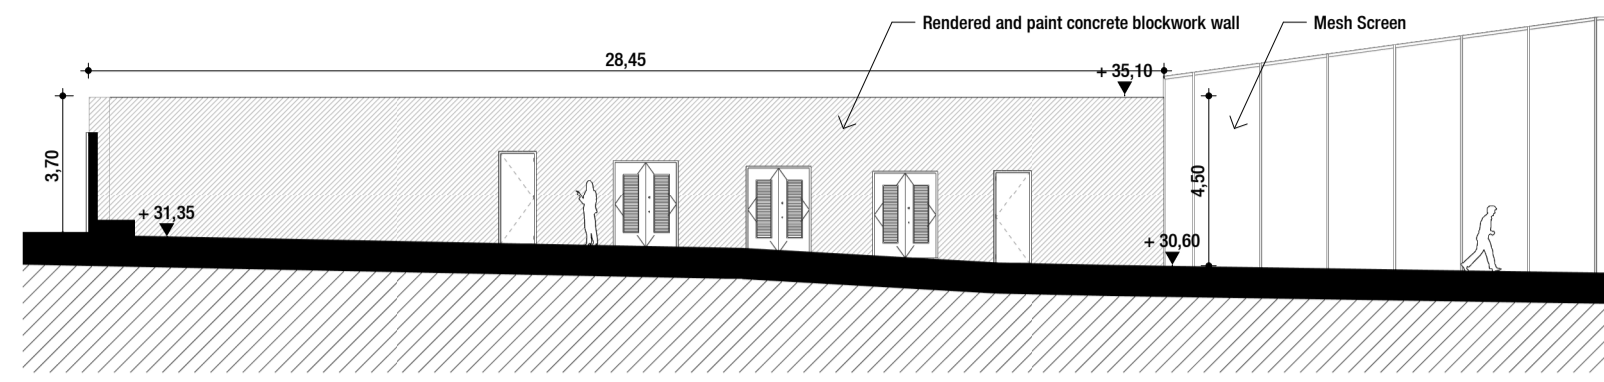


09 Ancillary Building Front Elevation
Scale 1:200

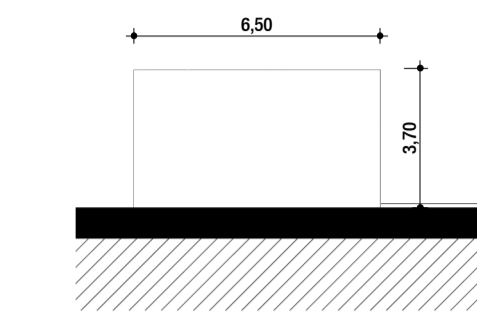


10 Ancillary Building Left Side Elevation
Scale 1:200

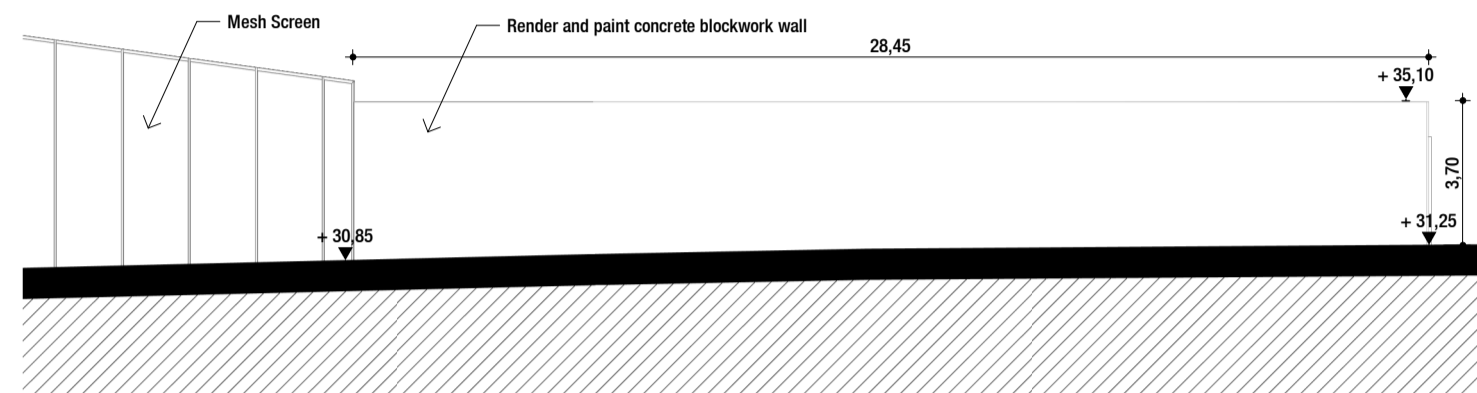


11 Ancillary Building Rear Elevation
Scale 1:200

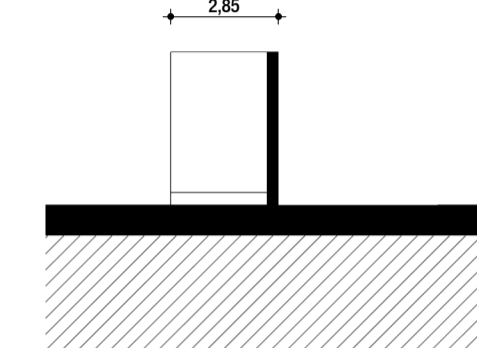


12 Ancillary Building Right Side Elevation
Scale 1:200

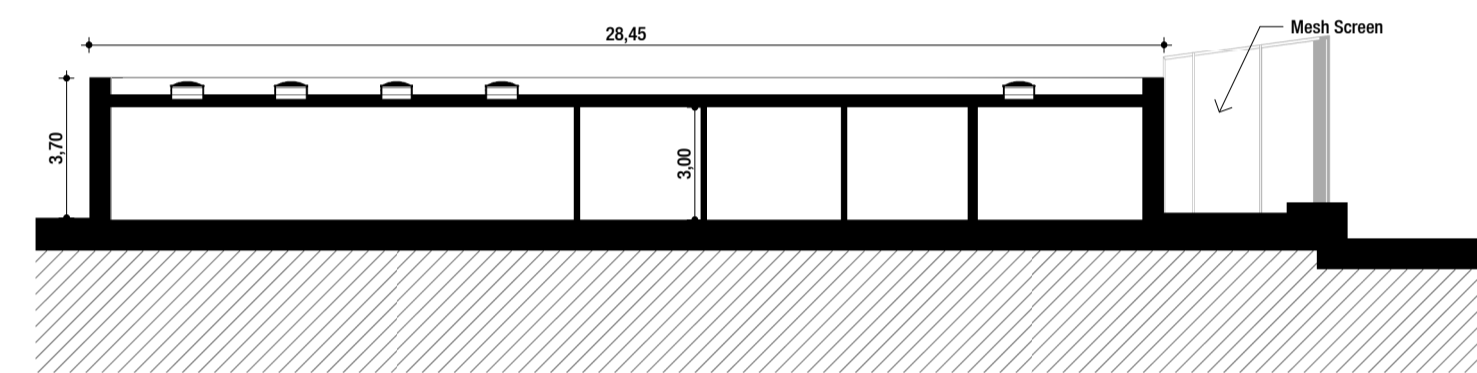


13 Ancillary Building Longitudinal Section
Scale 1:200

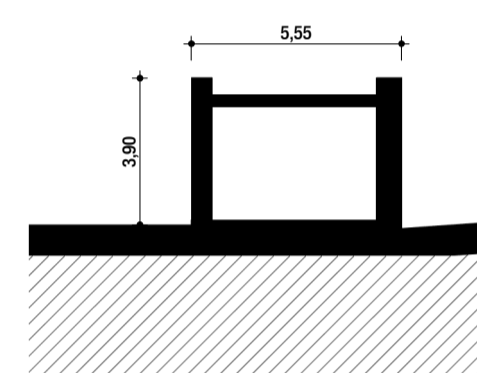

14 Ancillary Building Transversal Section
Scale 1:200

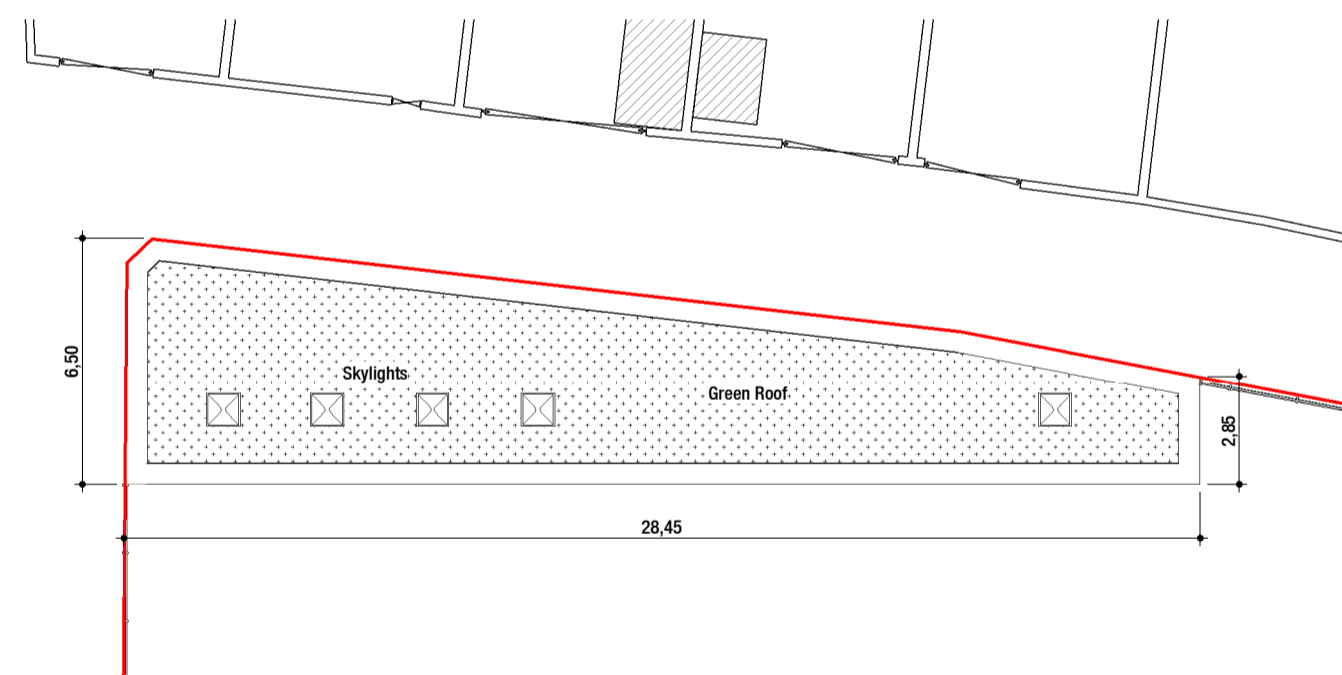

15 Utilities Building - Ground Floor
Scale 1:200

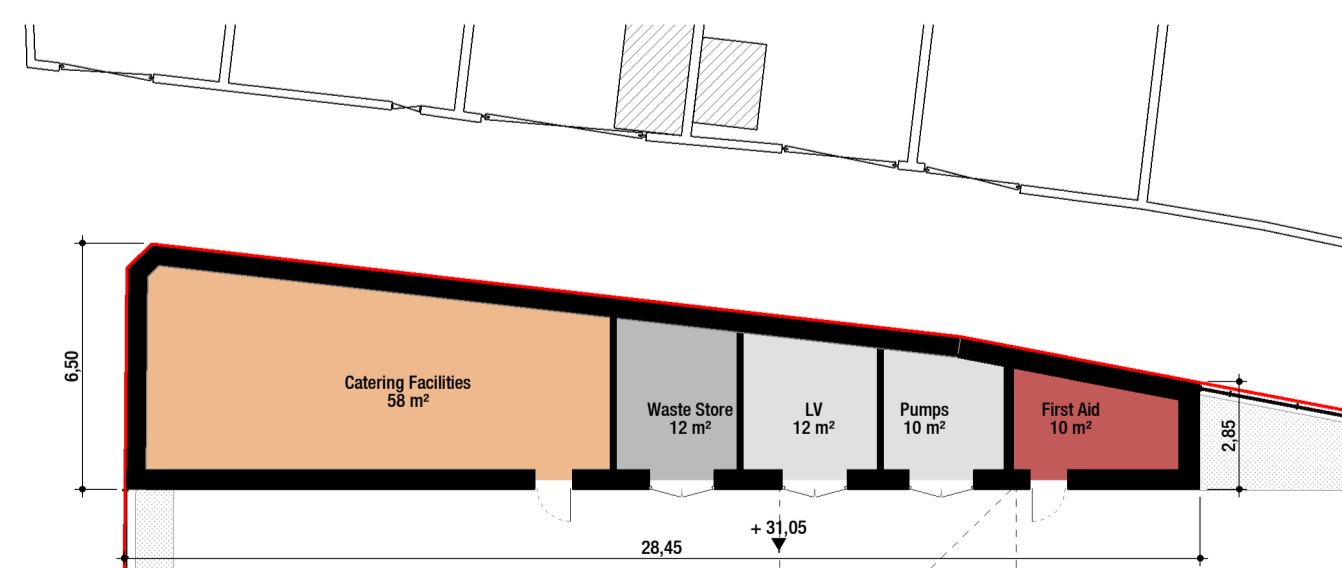

16 Utilities Building - Ground Floor
Scale 1:200


GENERAL NOTES:

- All dimensions are in millimeters. All vertical levels in metres and referenced to MSL datum unless noted otherwise.
- All Architecture drawings to be read in conjunction with all relevant specifications, Structural Engineer's drawings, Services Engineer's and other Specialist's drawings. Any discrepancies between graphic and written information must be immediately reported to the Architect in writing.

KEY TO MATERIALS:

- Mesh screen
- Rendered blockwork wall
- Brickwork
- Feature brickwork
- Anthracite coated/painted roof metal deck
- Steelwork (anthracite-coated)

KEY PLAN:

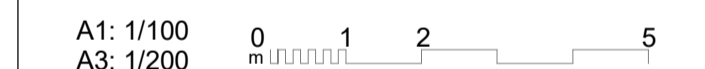

03	01/09/2023	FOR PLANNING	AA	VB	VB
Ver	Date	Issue Details	Dwn	Chd	App

Client

Comhairle Cathrach
Bhaile Átha Cliath
Dublin City Council

Project

**Dalymount Park
Stadium Redevelopment**

Dwg Title

**Proposed ESB Substation & Ancillary
Building Elevations, Sections**

Scale	Date	Client Project No.	Origin. Project No.
A1 1:200 A3 1:400	01/09/2023	-	P - 102025
Drawn	Checked	Approved	Approved
AA	VB	VB	VB
Drawing No.	102025-IDO-DR-A-2210-XX-ZZ		Status Revision
			S4 03

Architects & Engineers